APPLICABLE CONTRACT DRAWINGS

BOUNDARIES PROJECT LOCATION SPARE BELLOW B

ISSUED FOR CONSTRUCTION

DESIGN PACKAGE DP #3 SCA WATER TREATMENT PLANT (WTP) TOWN OF CAMILLUS, NEW YORK

HONEYWELL INTERNATIONAL, INC. MORRISTOWN, NEW JERSEY

MARCH 22, 2010



O'BRIEN & GERE

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IT IS A VIOLATION OF LAW FOR ANY PERSON UNLESS ACTING UNDER THE DIRECTION OF A LICENSED PROFESSIONAL ENGINEER TO ALTER THIS DOCUMENT.

IPC's ISOMETRIC

LGAC ISOMETRIC

DETAILS

M - 15

FILTER FEED ISOMETRIC

EFFLUENT MONITORING TANKS ISOMETRIC

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OVERALL SITE & KEY PLAN
                                                                  LEGEND & SYMBOLS
                                                                  LEGEND & SYMBOLS
           EFFLUENT PIPELINE PLAN; STA 24+29 TO 41+40
           EFFLUENT PIPELINE PLAN; STA 41+40 TO 51+91
           EFFLUENT PIPELINE PROFILE; STA 0+00 TO 21+00
           EFFLUENT PIPELINE PROFILE; STA 21+00 TO 51+91
                                                         I-09 CARBON FILTERS
                                                                 EFFLUENT MONITORING TANK #1
                                                                 EFFLUENT MONITORING TANK #2
           BACKWASH PUMPING STATION SECTIONS,
                                                                  BACKWASH/SLUDGE PUMPING STATION
           PLAN, AND DETAILS
                                                                 OUTDOOR CHEMICAL STORAGE - H2SO4/UNLOADING
  MD-4 MISCELLANEOUS DETAILS
                                                                  OUTDOOR CHEMICAL STORAGE - NAOH/ALUM
ARCHITECTURAL

A-0 CODE REVIEW ANALYSIS

A-1 FLOOR PLAN
                                                                  CHEMICAL FEED SYSTEMS - NAOH
                                                         1 - 15
                                                                  CHEMICAL FEED SYSTEMS - H2SO4
                                                                  CHEMICAL FEED SYSTEMS - ALUM
                                                                  AIR COMPRESSOR
                                                         1 - 18
                                                                  VENT HEADER
           ELEVATIONS
                                                         1 - 19
                                                                  VAPOR PHASE CARBON FILTER
           BUILDING SECTIONS
                                                                  CHEMICAL STORAGE ANIONIC POLYMER
           ENLARGED PLAN & INTERIOR ELEVATIONS
                                                                  WTP BUILDING SUMPS
           SCHEDULES & DETAILS
                                                                 LEGEND & ABBREVIATIONS
            GENERAL NOTES
                                                                FLOOR PLAN
           OVERALL SITE PLAN
           NORTHWEST PILE AND FOUNDATION PLAN
                                                                ENLARGED PLAN
           NORTHEAST PILE AND FOUNDATION PLAN
                                                                SCHEDULES
           SOUTHWEST PILE AND FOUNDATION PLAN
           SOUTHEAST PILE AND FOUNDATION PLAN
           EQUIPMENT FOUNDATION PLAN
                                                               LEGEND & ABBREVIATIONS
          ROOF PLAN
                                                               WATER PIPING PLAN
           FOUNDATION SECTIONS & DETAILS
                                                                ENLARGED WATER PIPING PLAN
           SECTIONS & DETAILS
                                                                ENLARGED DRAINAGE PIPING PLAN
           TYPICAL DETAILS
                                                                SECTIONS, DETAILS & SCHEDULES
           BULK CHEMICAL STORAGE PLANS
                                                               WATER PIPING SCHEMATIC
          BULK CHEMICAL STORAGE SECTIONS
                                                                  ABBREVIATIONS, SYMBOLS AND GENERAL NOTES
          PROCESS FLOW DIAGRAM
                                                                 GROUNDING PLAN
          MASS BALANCE - DREDGE SEASON
                                                                 MCC1 ONE-LINE DIAGRAM
           MASS BALANCE - WINTER SEASON
                                                                 MCC1 ONE-LINE DIAGRAM CONTINUED
           GENERAL NOTES
                                                                 MCC2 ONE-LINE DIAGRAM
          WTP ISOMETRIC
                                                                  MCC2 ONE-LINE DIAGRAM CONTINUED
                                                                  NORTHWEST POWER PLAN
           EQUIPMENT LOCATION PLAN
                                                                  NORTHEAST POWER PLAN
           PARTIAL PLAN
                                                                  SOUTHWEST POWER PLAN
           PARTIAL PLAN
                                                                  SOUTHEAST POWER PLAN
           PH ADJUSTMENT TANKS ISOMETRIC
                                                                  NORTHWEST LIGHTING PLAN
           IPC's ISOMETRIC
                                                                  NORTHEAST LIGHTING PLAN
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SOUTHWEST LIGHTING PLAN

SOUTHEAST LIGHTING PLAN

FIRE ALARM SYSTEM PLAN

ELEMENTARY DIAGRAMS

ELEMENTARY DIAGRAMS
ELEMENTARY DIAGRAMS

ELEMENTARY DIAGRAMS

ELEMENTARY DIAGRAMS

ELEMENTARY DIAGRAMS

CONTROL SYSTEM OVERVIEW

POWER PLAN

LIGHTING PLAN


DETAILS


E - 24


ELECTRICAL ROOM 101 PLANS


ELECTRICAL ROOM 104/CONTROL ROOM AREA

ELECTRICAL ROOM 104/CONTROL ROOM AREA

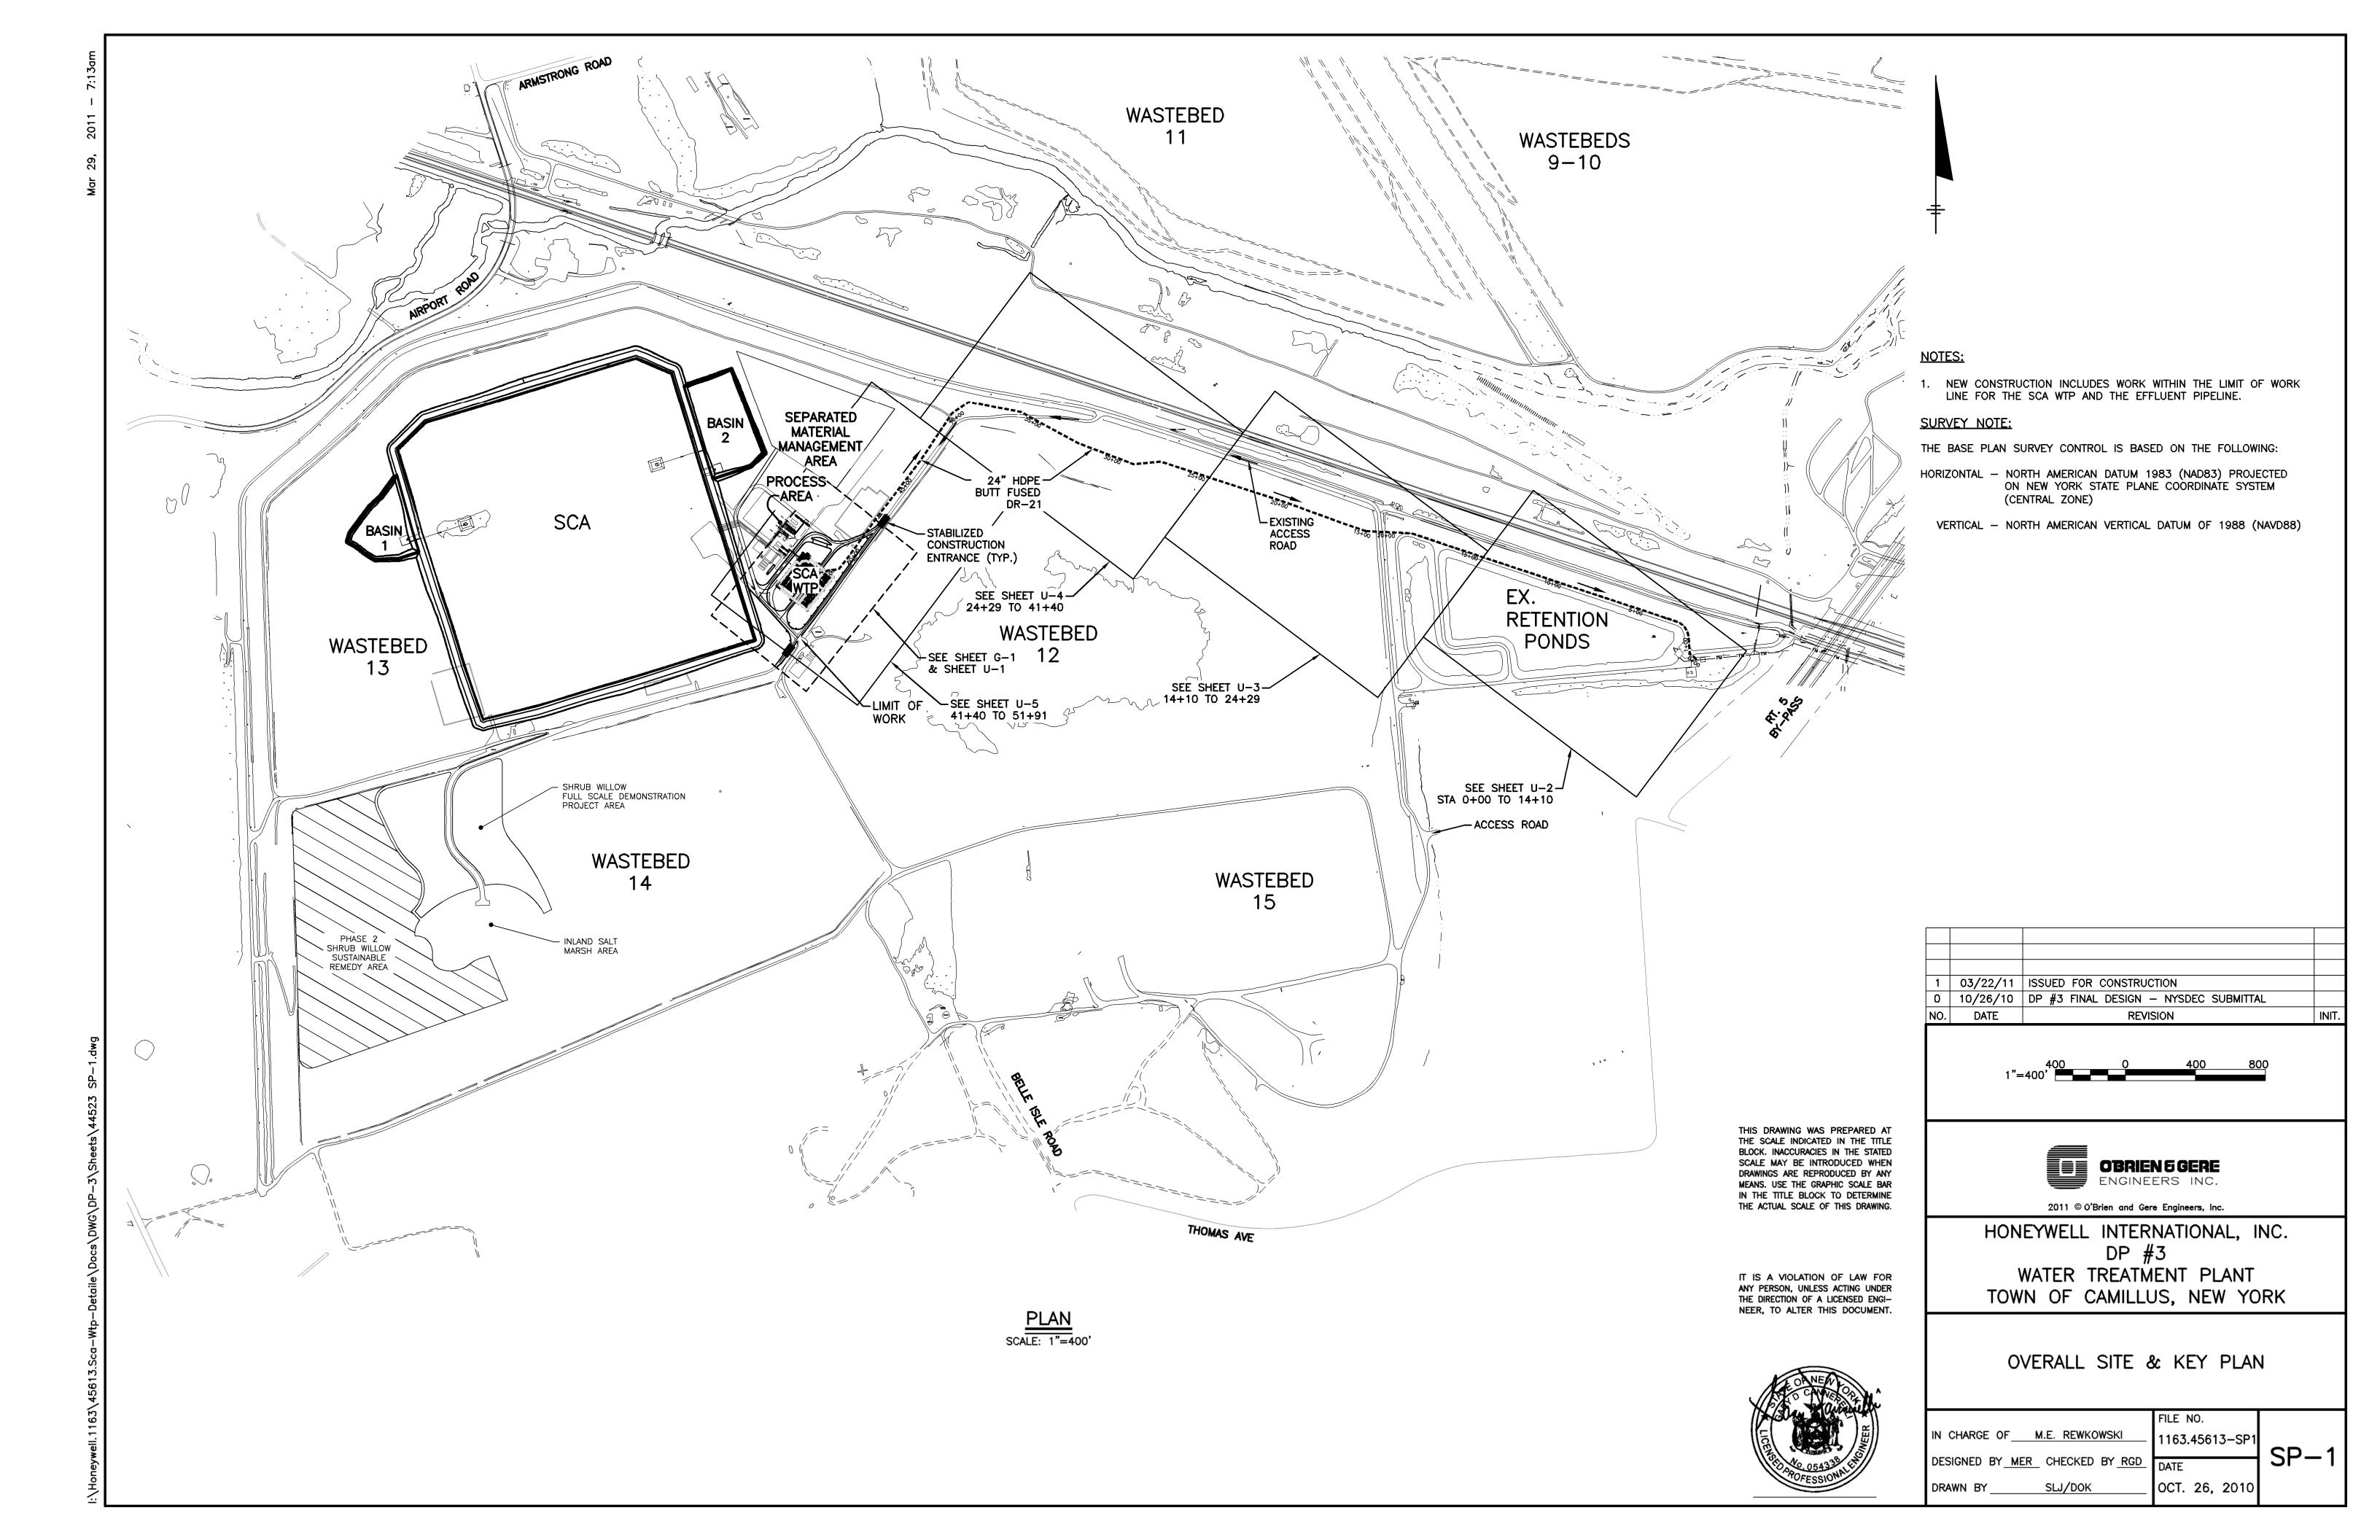


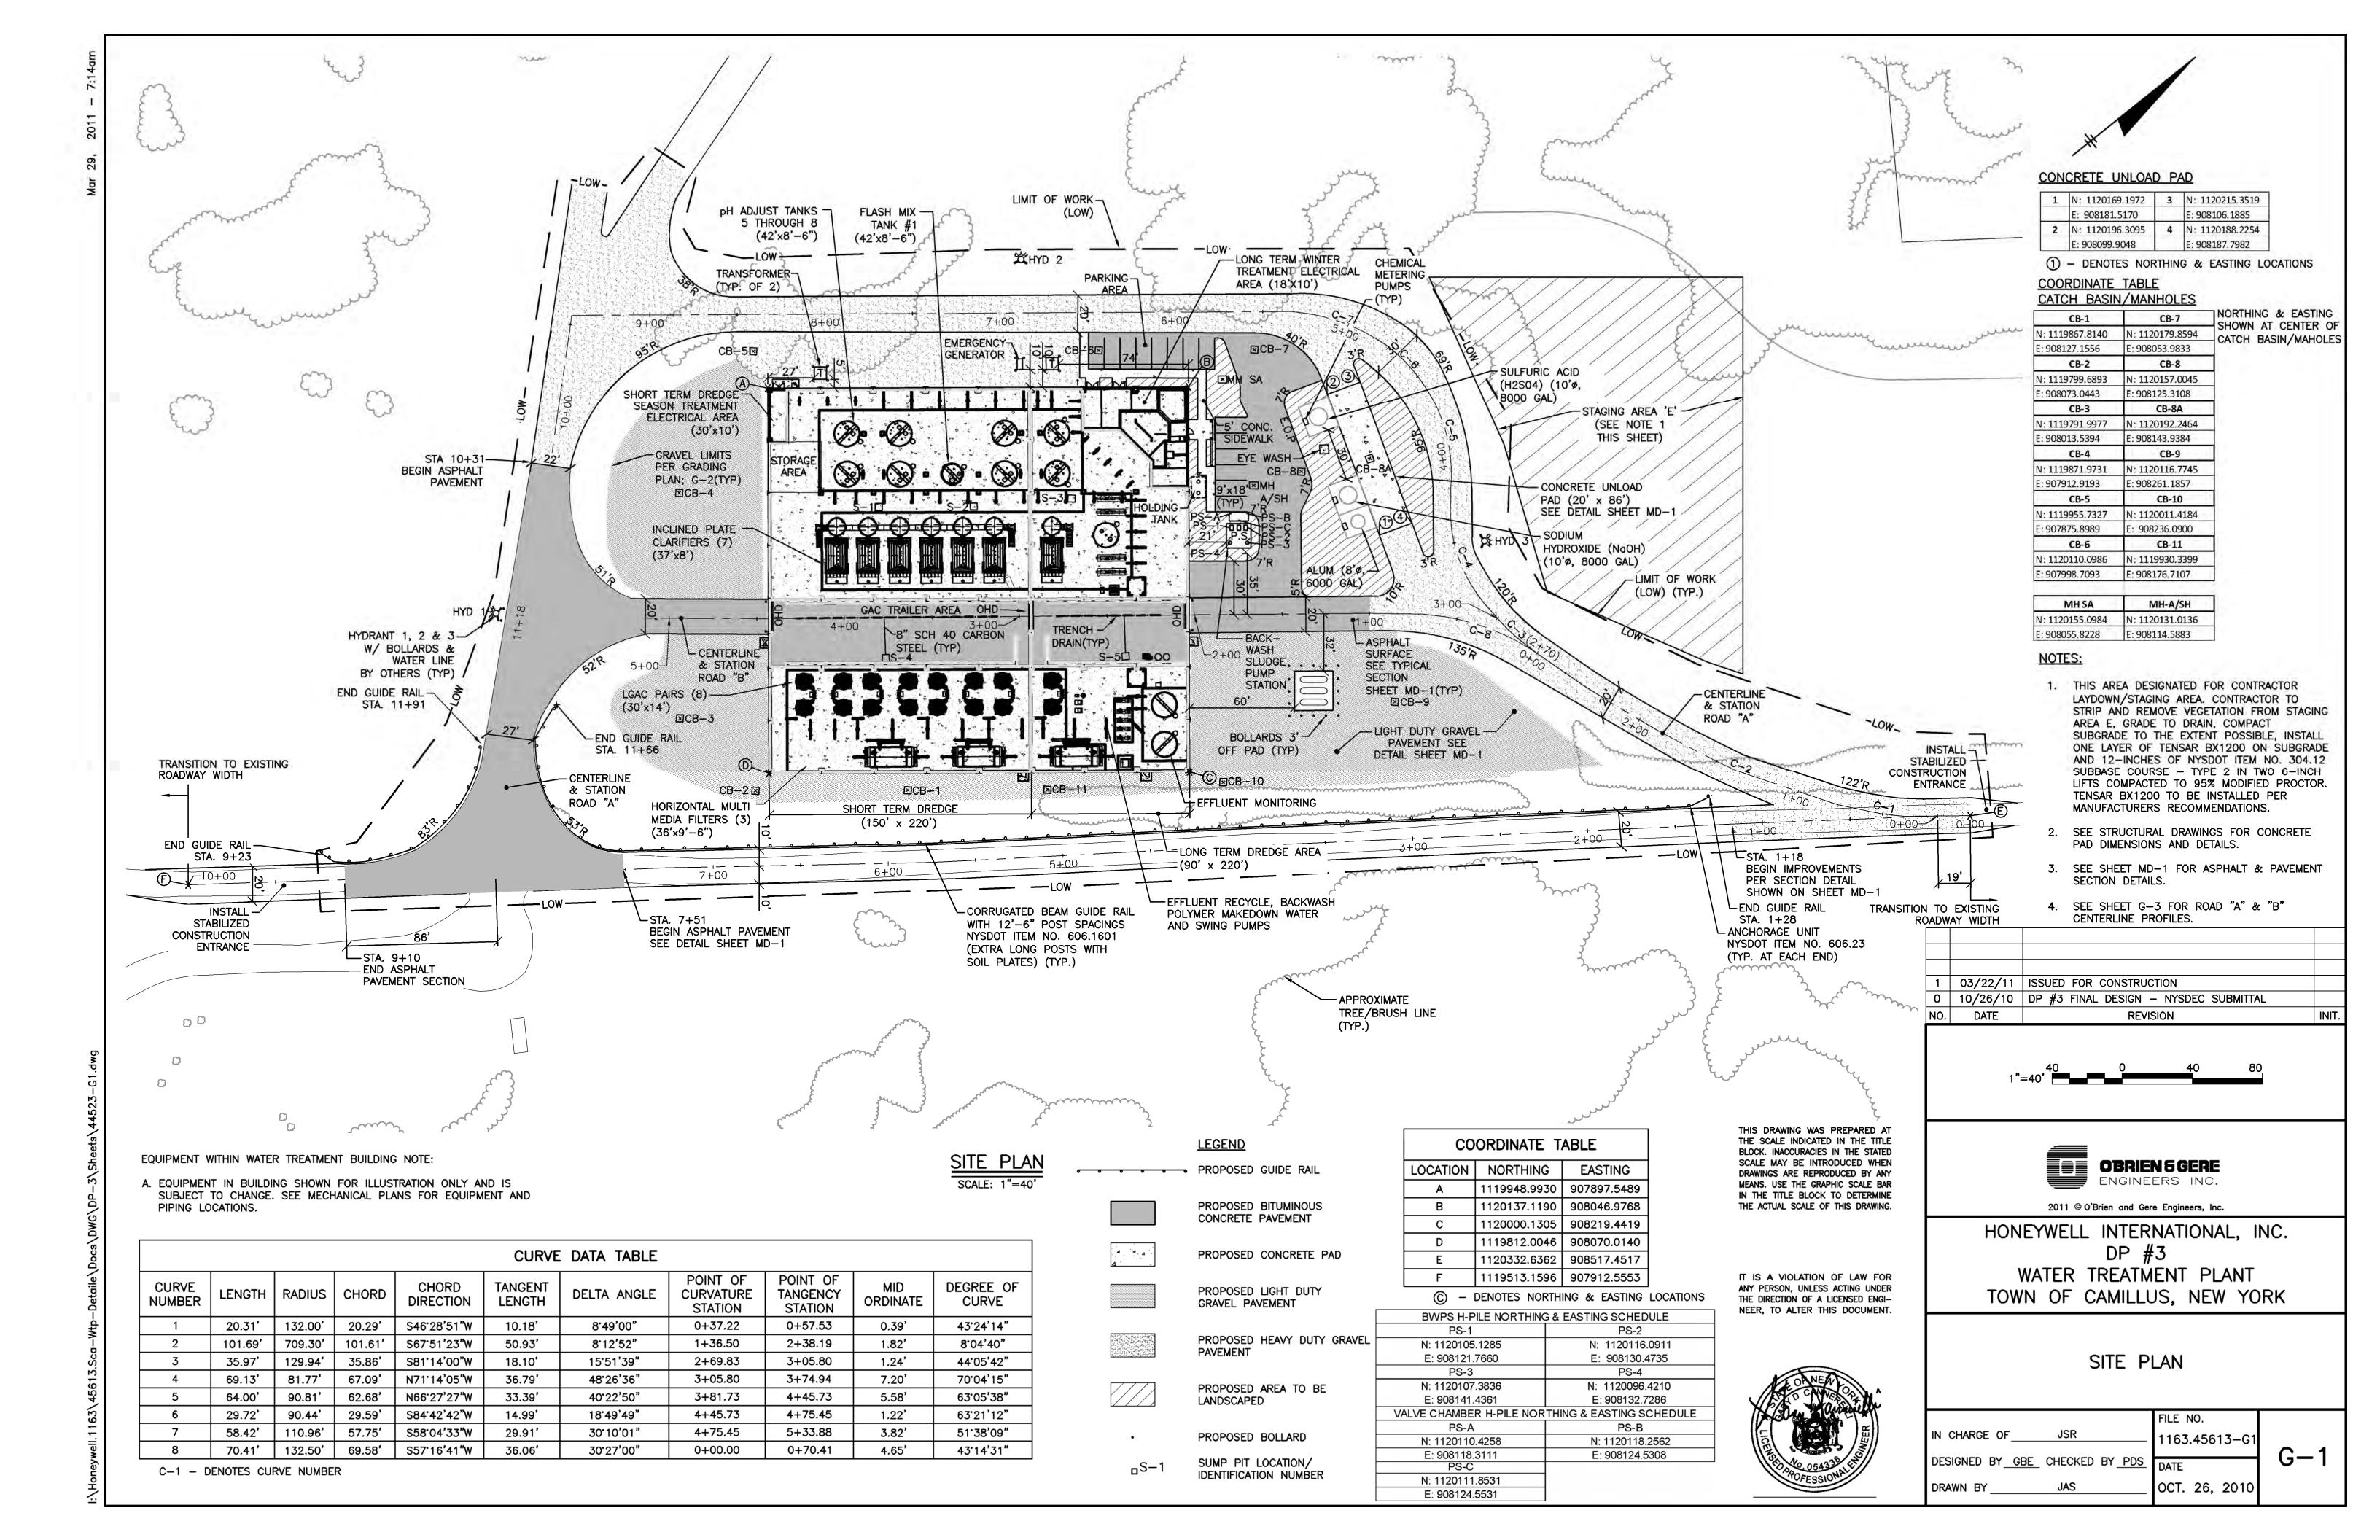

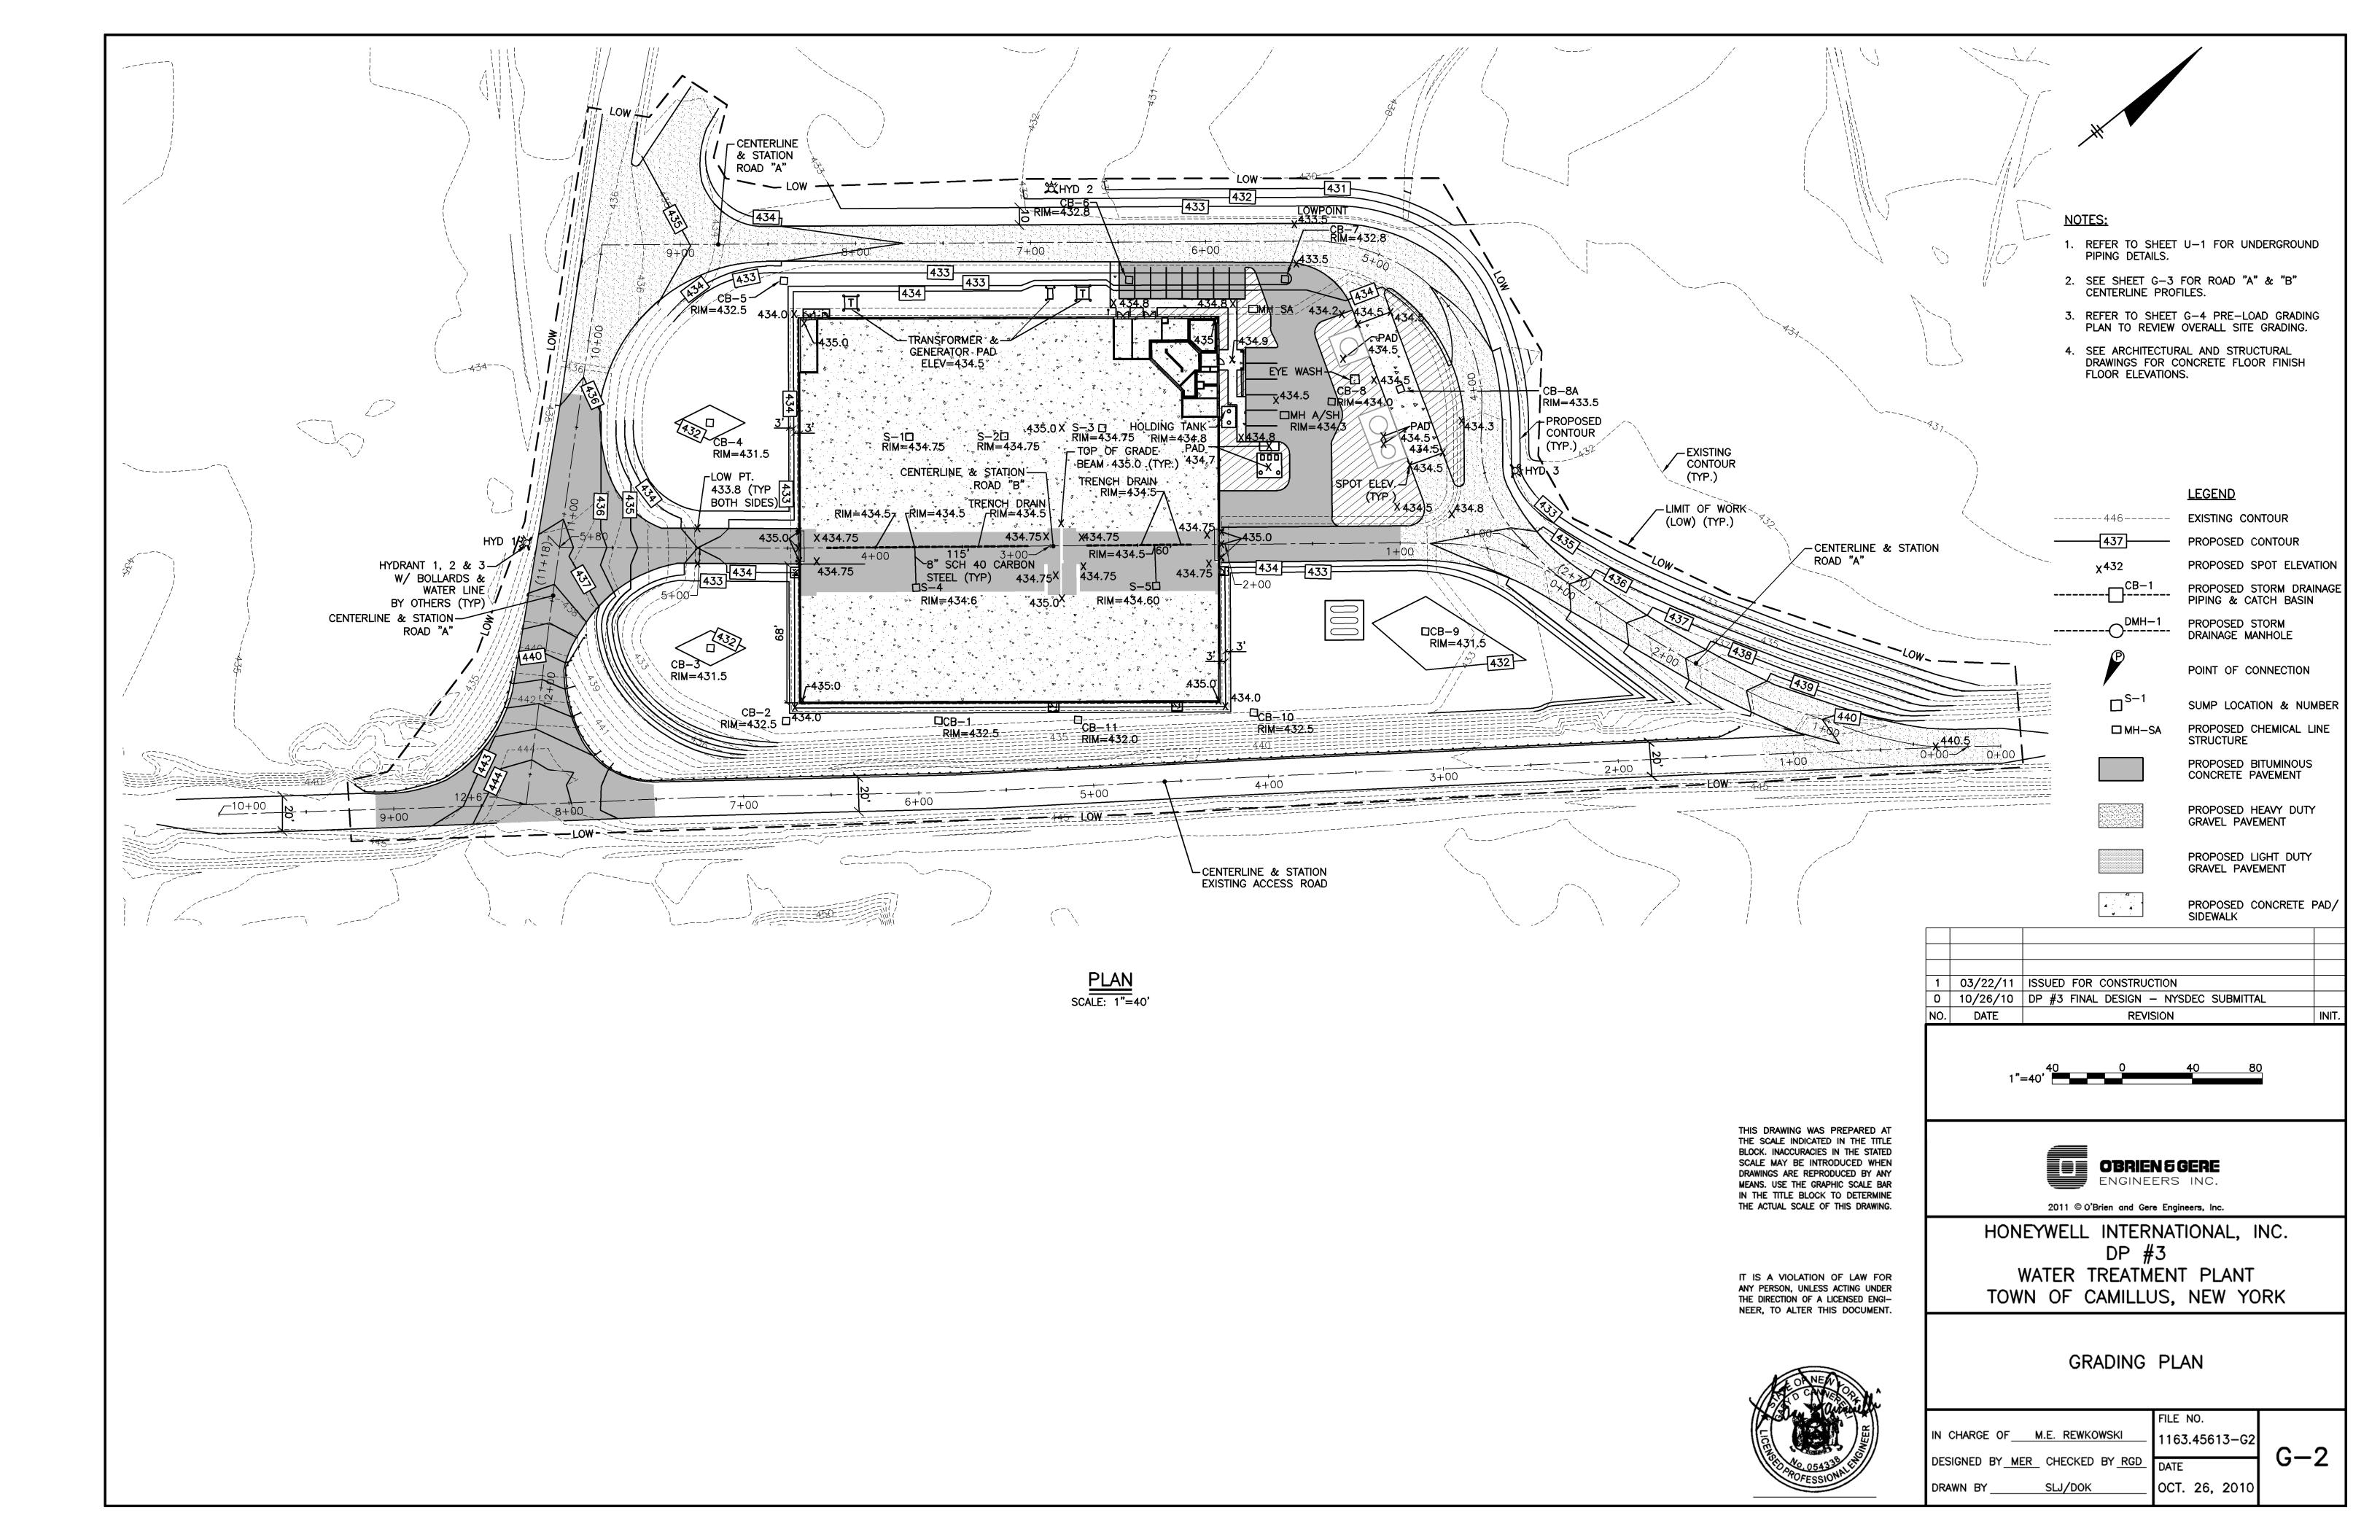

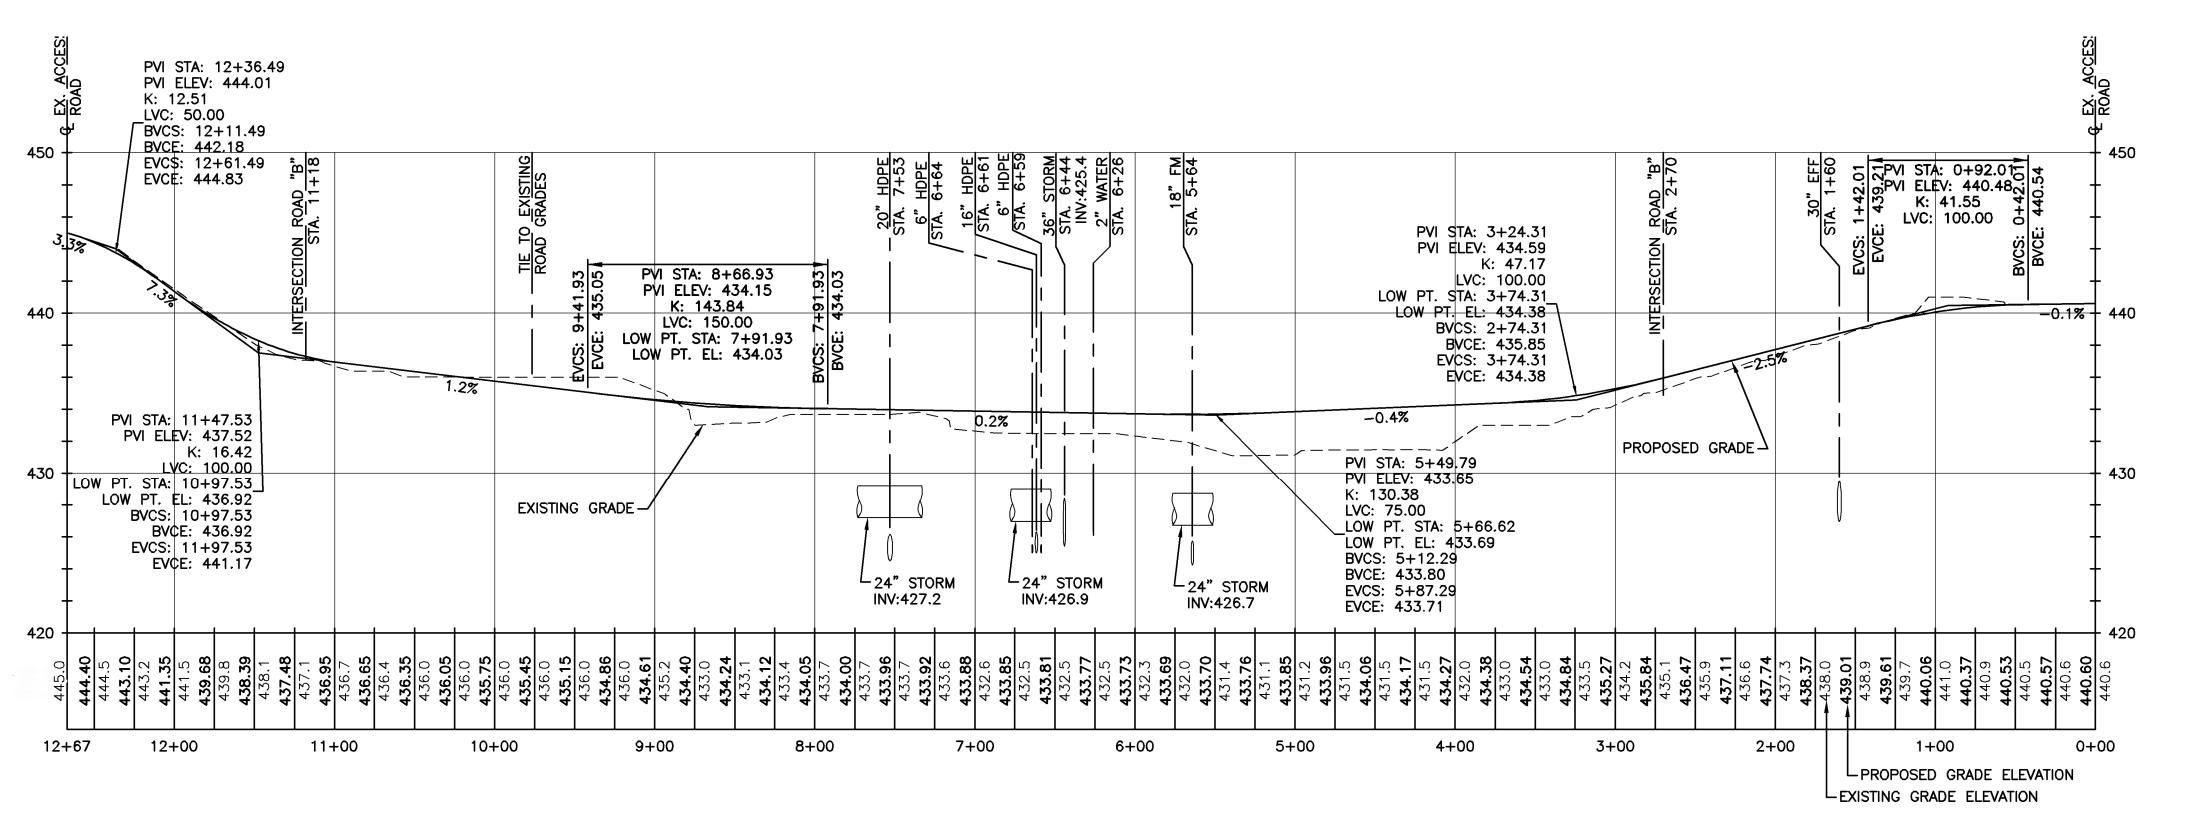

ROAD "A" CENTERLINE PROFILE SCALE: HORIZ. 1"=60' VERT. 1"=6'

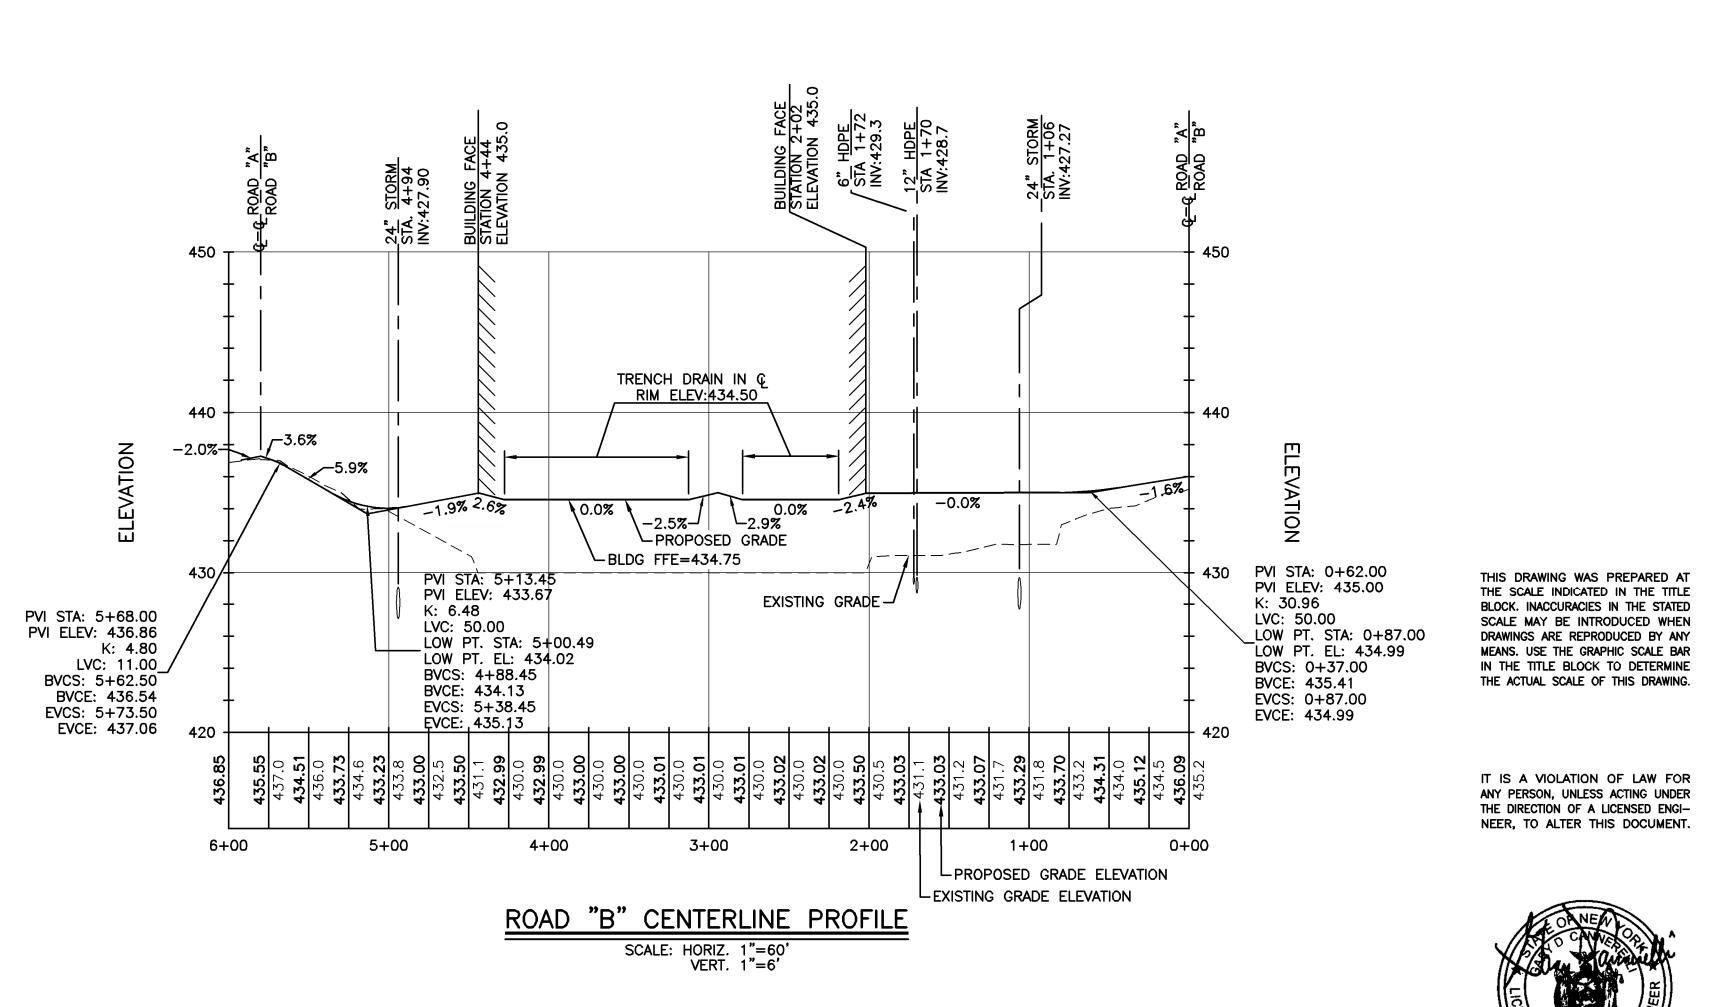

<u>ABBREVIATIONS</u>

BVCS BEGIN VERTICAL CURVE STATION
BVCE BEGIN VERTICAL CURVE ELEVATION
EVCS END VERTICAL CURVE STATION
EVCE END VERTICAL CURVE ELEVATION
PVI POINT OF VERTICAL INTERSECTION
LVC LENGTH OF VERTICAL CURVE
K RATE OF VERTICAL CURVATURE

SANITARY

1 03/22/11 ISSUED FOR CONSTRUCTION
0 10/26/10 DP #3 FINAL DESIGN — NYSDEC SUBMITTAL
NO. DATE REVISION INI

1"=6" 60 0 6 12

1"=60" 60 0 60 120



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HONEYWELL INTERNATIONAL, INC.

DP #3

WATER TREATMENT PLANT TOWN OF CAMILLUS, NEW YORK

ROAD "A" & "B"
CENTERLINE PROFILES

IN CHARGE OF M.E. REWKOWSKI 1163.45613—G3

DESIGNED BY MER CHECKED BY RGD DATE

DRAWN BY SLJ/DOK OCT. 26, 2010

